12 Riverview Road, Earlwood, NSW 2206

Landscape Documentation for S4.55



Drawing Register

- Dwg No. Drawing Name
- S4.55-000 Cover Sheet & Design Statement
- S4.55-101 Landscape Site Plan
- S4.55-102 Landscape Level 1
- S4.55-201 Landscape Elevation North
- S4.55-601 Landscape Specification & Details
- Plant Schedule & Images S4.55-602

Drawing Title **COVER SHEET & DESIGN STATEMENT**

S4.55-000



CAD DRAFT

DWG No:

IMAGE TAKEN FROM NEARMAP 2018

Design Statement

Landscape Philosophy

These drawings are for the proposed landscaping of 12 Riverview Road, Earlwood, as part of a Development Application. The plans are in accordance with Canterbury Development Control Plan 2012. One canopy tree is planted within each of the front and rear setbacks. Screening shrubs are proposed to each side boundaries. Tree and shrubs are used to reduce the scale of the development and blend into the surrounding landscape. Plant species, selected to replace the removed landscaped embankment, are native and endemic to the local area. Climbers on tensile steel wires are used to create a green wall to the Riverview Road frontage.

Landscape Management


The landscape will be maintained by the Client. A low volume drip irrigation system is recommended to all planters to optimise establishment of the landscape.

SITE PLAN



	Scale:	Date:	Job Number:	North:	Revision			FOR \$4.55	
T PTY LTD	N/A	16.09.2022	170203	(\mathbf{F})			Description	Drawn PT	Checked BG
3	Project:	12 Rivervi	ew Road		A	16.09.22	FOR 54.55		
G STREET, ROZELLE, NSW SVILLE 2111 info@caddraftnsw.com.au		Earlwood, NSW 2206							

SCALE: NTS

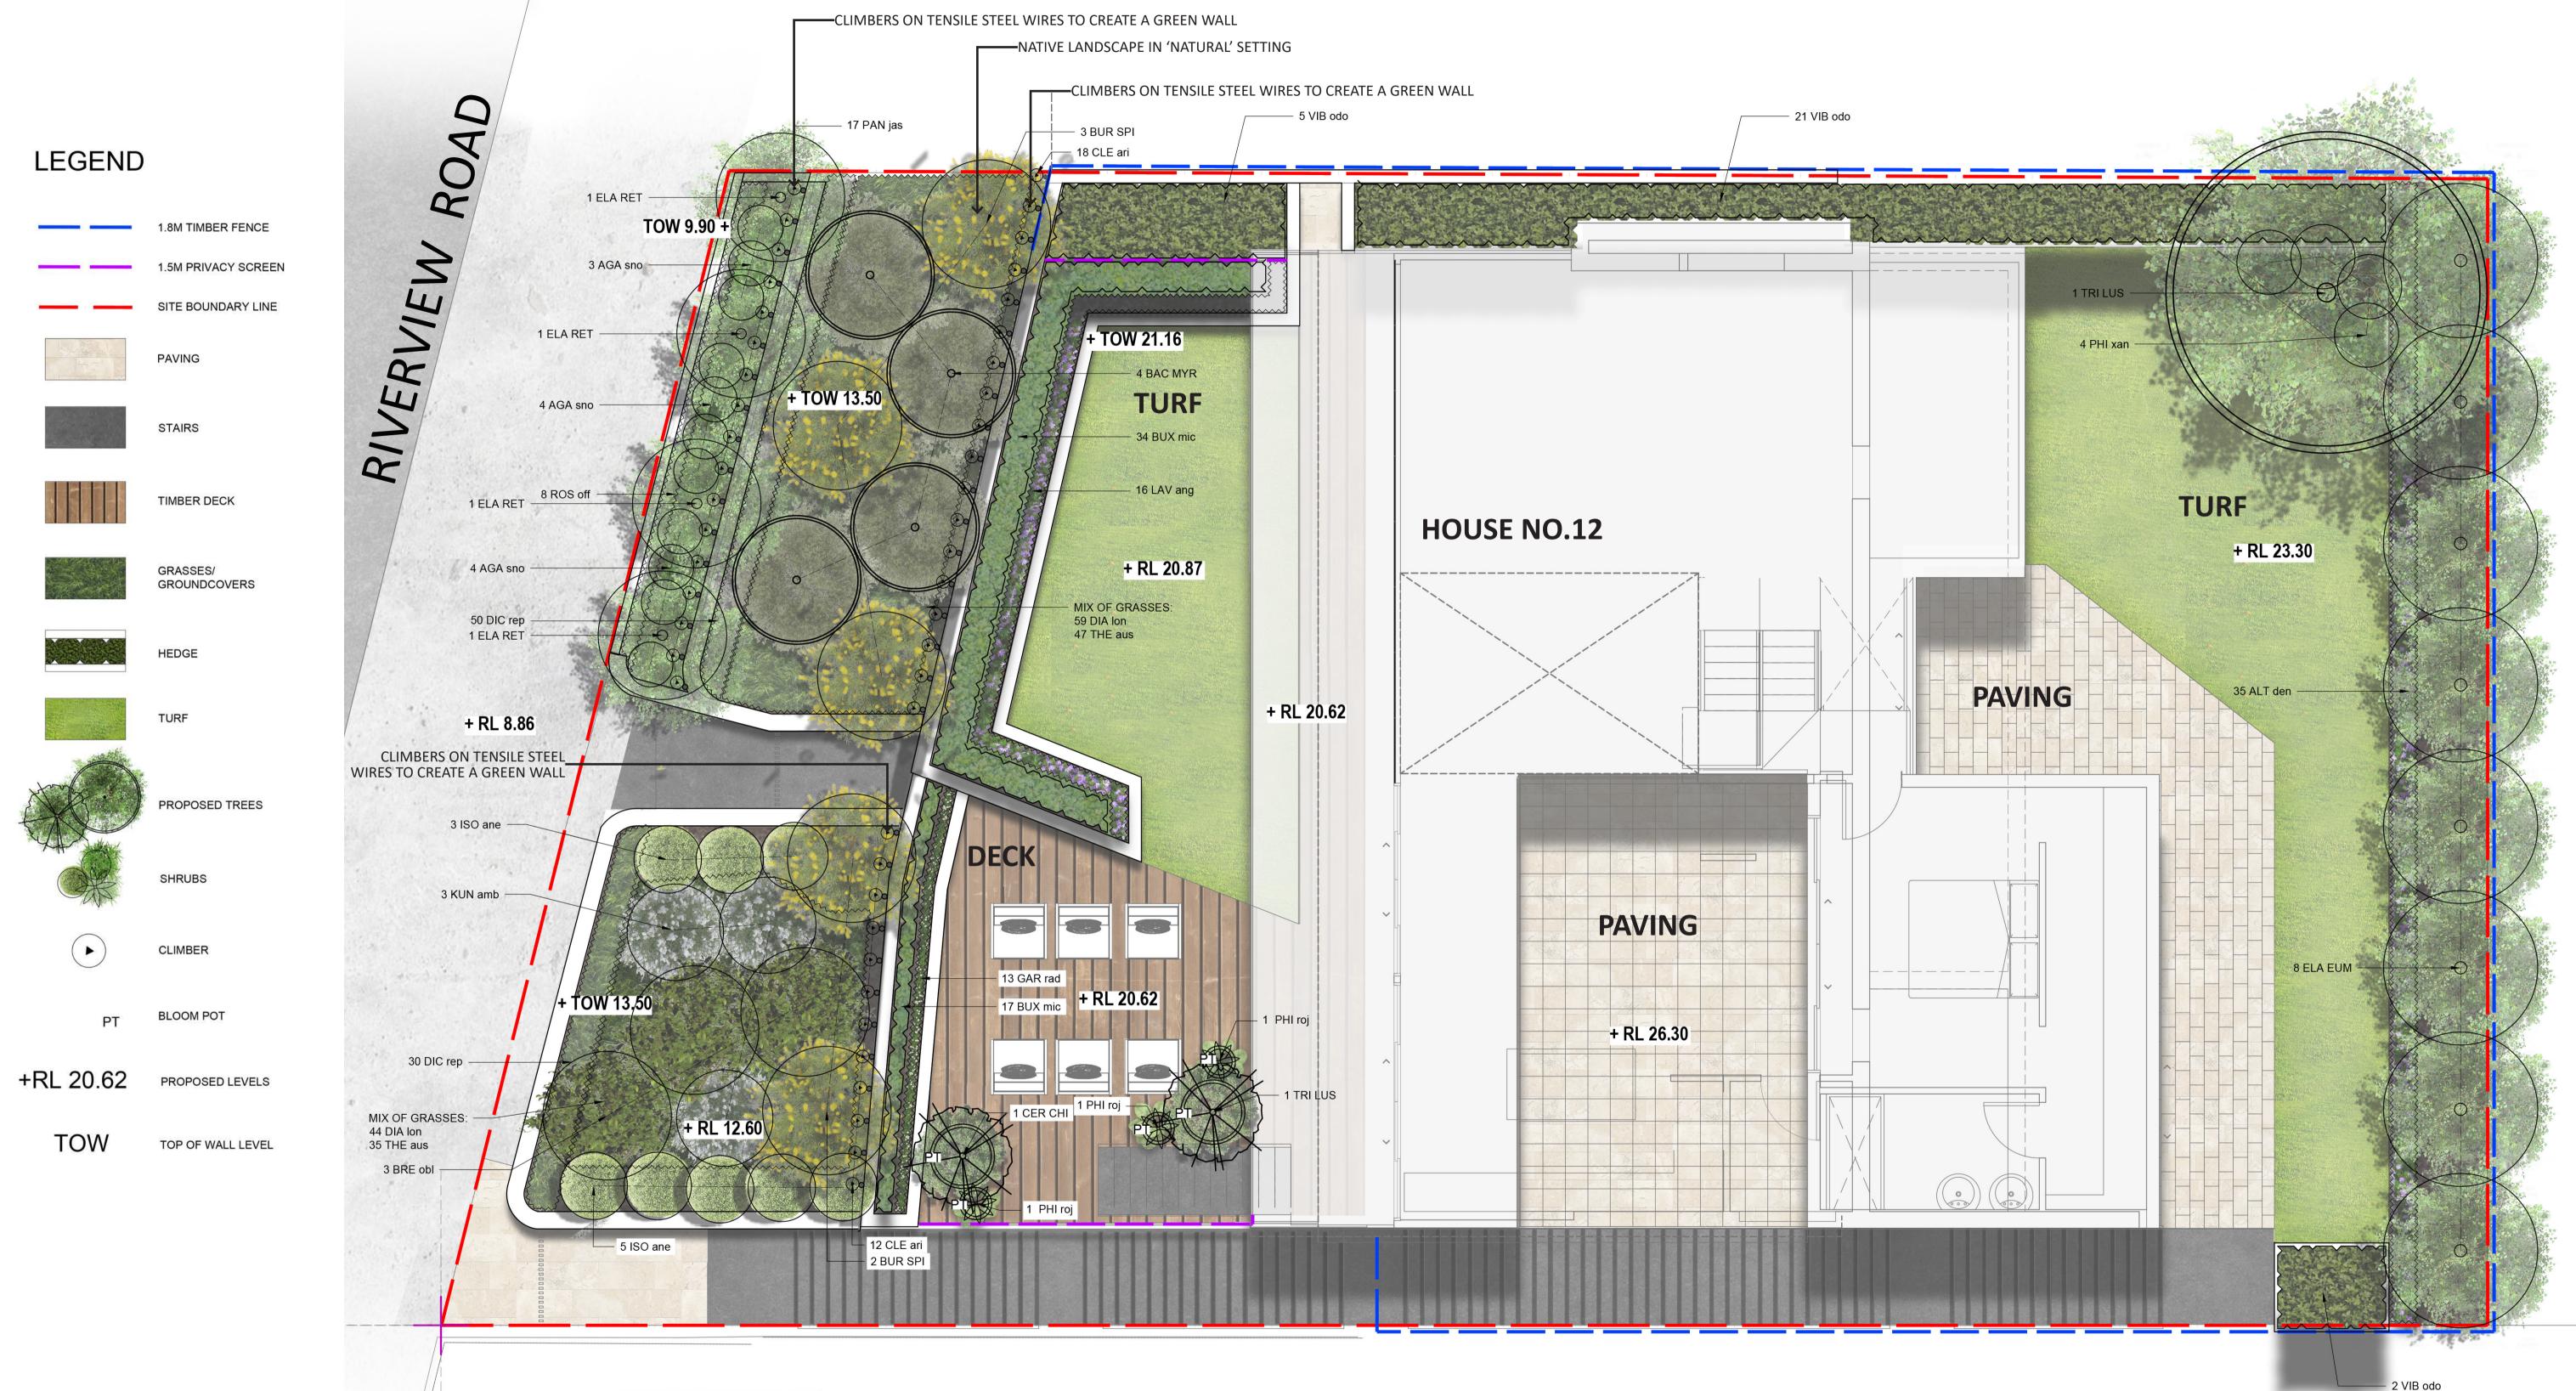

Drawing Title LANDSCAPE SITE PLAN

DWG No:

Suite 215, 284 Victoria Av, Chatswood NSW 2067 Ph. (02) 9411 1485 www.geoscapes.com.au ABN 84 620 205 781 ACN 620 205 781

Architect: CAD DRAFT PTY LTD ABN: 27 083 288 153 PH: 9555 8545

S4.55-101



Date: Scale: 1:50 @ A1 1:100 @ A3 16.09.2022 **12 Riverview** Project: SUIT 4, 670 DARLING STREET, ROZELLE, NSW info@caddraftnsw.com.au

P.O BOX 446 GLADESVILLE 2111

Job Number:	North:	Revi	sion	F	FOR \$4.55		
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Earlwood, NSW	/ 2206						


LEGEND



TOP OF WALL LEVEL

NARROW TROUGH PLANTER

S4.55-102

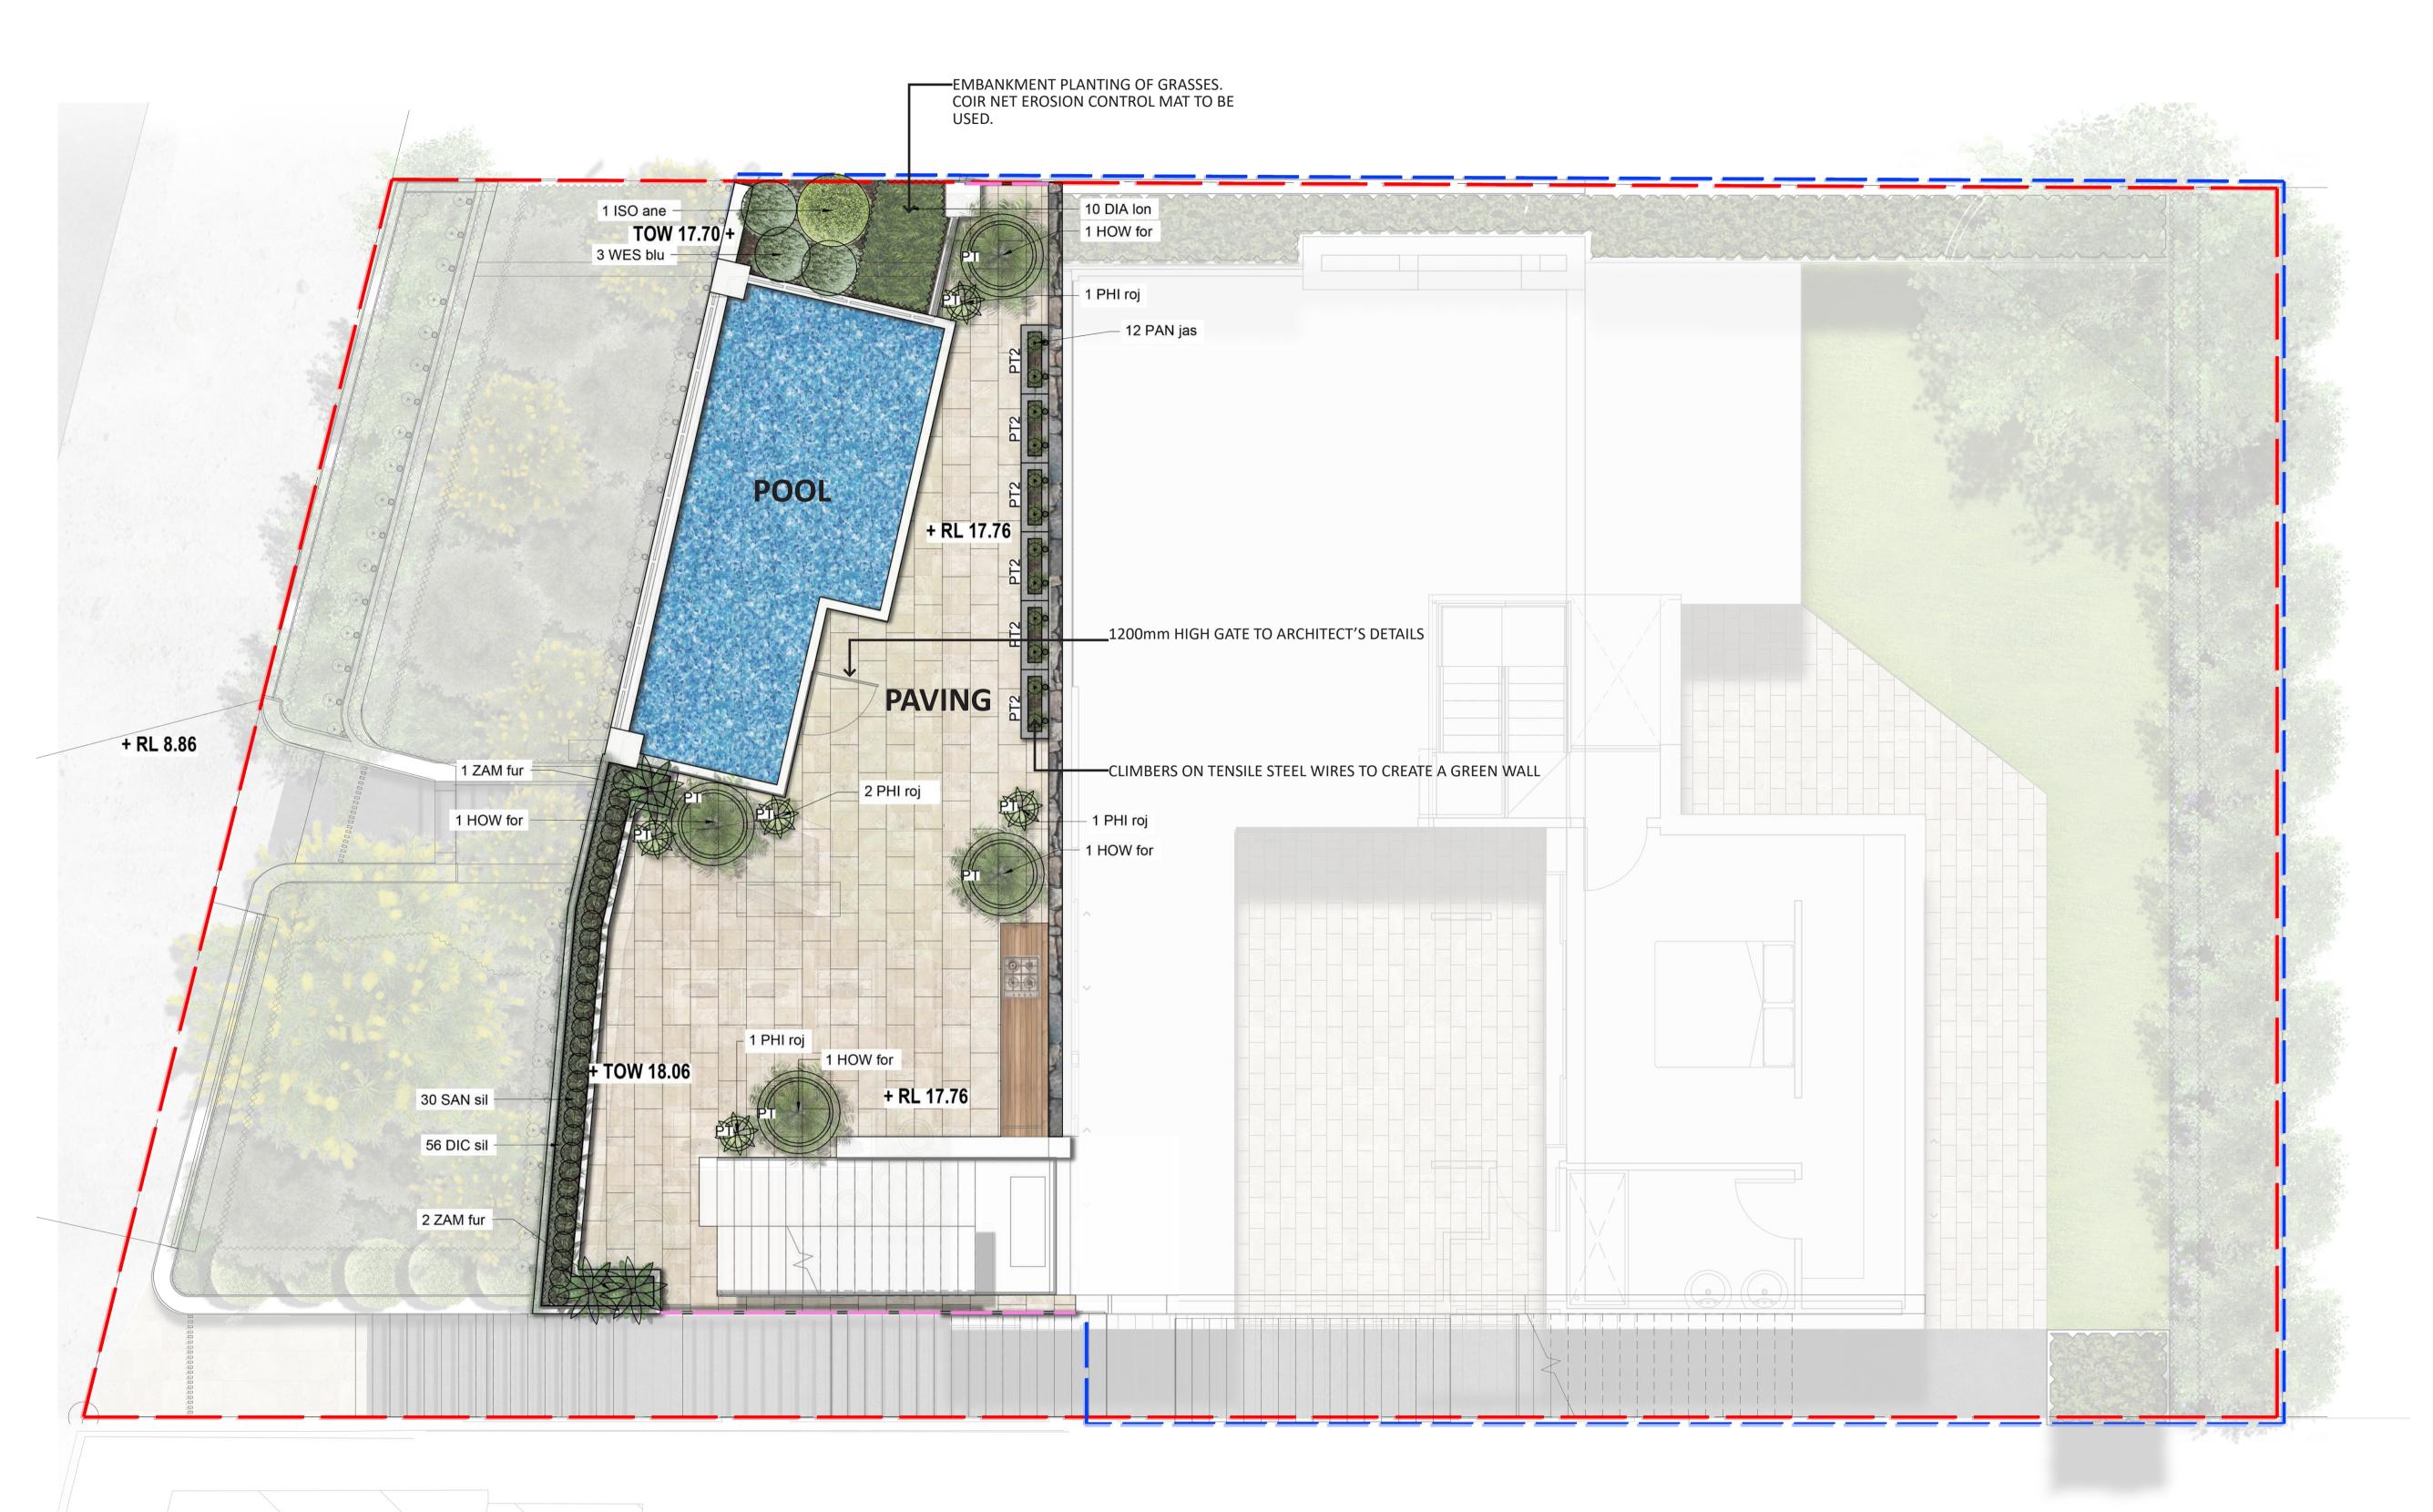

Drawing Title LANDSCAPE LEVEL 1

TOW

PT2

DWG No:







info@caddraftnsw.com.au

Job Number:	North:	Revi	sion	F	FOR \$4.55		
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w Road							
Earlwood, NSW	/ 2206						
		L	I	1		1	

Canopy tree to rear garden-

Continuation of shaped Buxusand Lavender creates continuity between levels. Raised garden bed to act as balustrade and provide visual screen

Feature sandstone wall with-Pandorea climbers on tensile steel wires to create a green wall. Pandorea climbers to be planted in narrow planter boxes.

Pot with feature palm on the deck-

Narrow Trough Planter-

Proposed pool to Architect's detail-

Coir net erosion control mat withgrasses planted in between.

Feature sandstone wall with_ Clematis climbers on tensile steel wires to create a green wall. Refer to detail 5 Native landscape in 'Natural' setting. Species include: Backhousia, Bursaria and Themeda

Feature sandstone wall with-Pandorea climbers on tensile steel wires to create a green wall.

Screen planting with drappingrosemary over sandstone wall. Elaeocarpus to achieve a conical appearance Drawing Title LANDSCAPE ELEVATION


S4.55-201

DWG No:

Suite 215, 284 Victoria Av, Chatswood NSW 2067 Ph. (02) 9411 1485 www.geoscapes.com.au ABN 84 620 205 781 ACN 620 205 781

Architect:

ABN: 27 083 288 153 PH: 9555 8545 P.O BOX 446 GLADESVILLE 2111

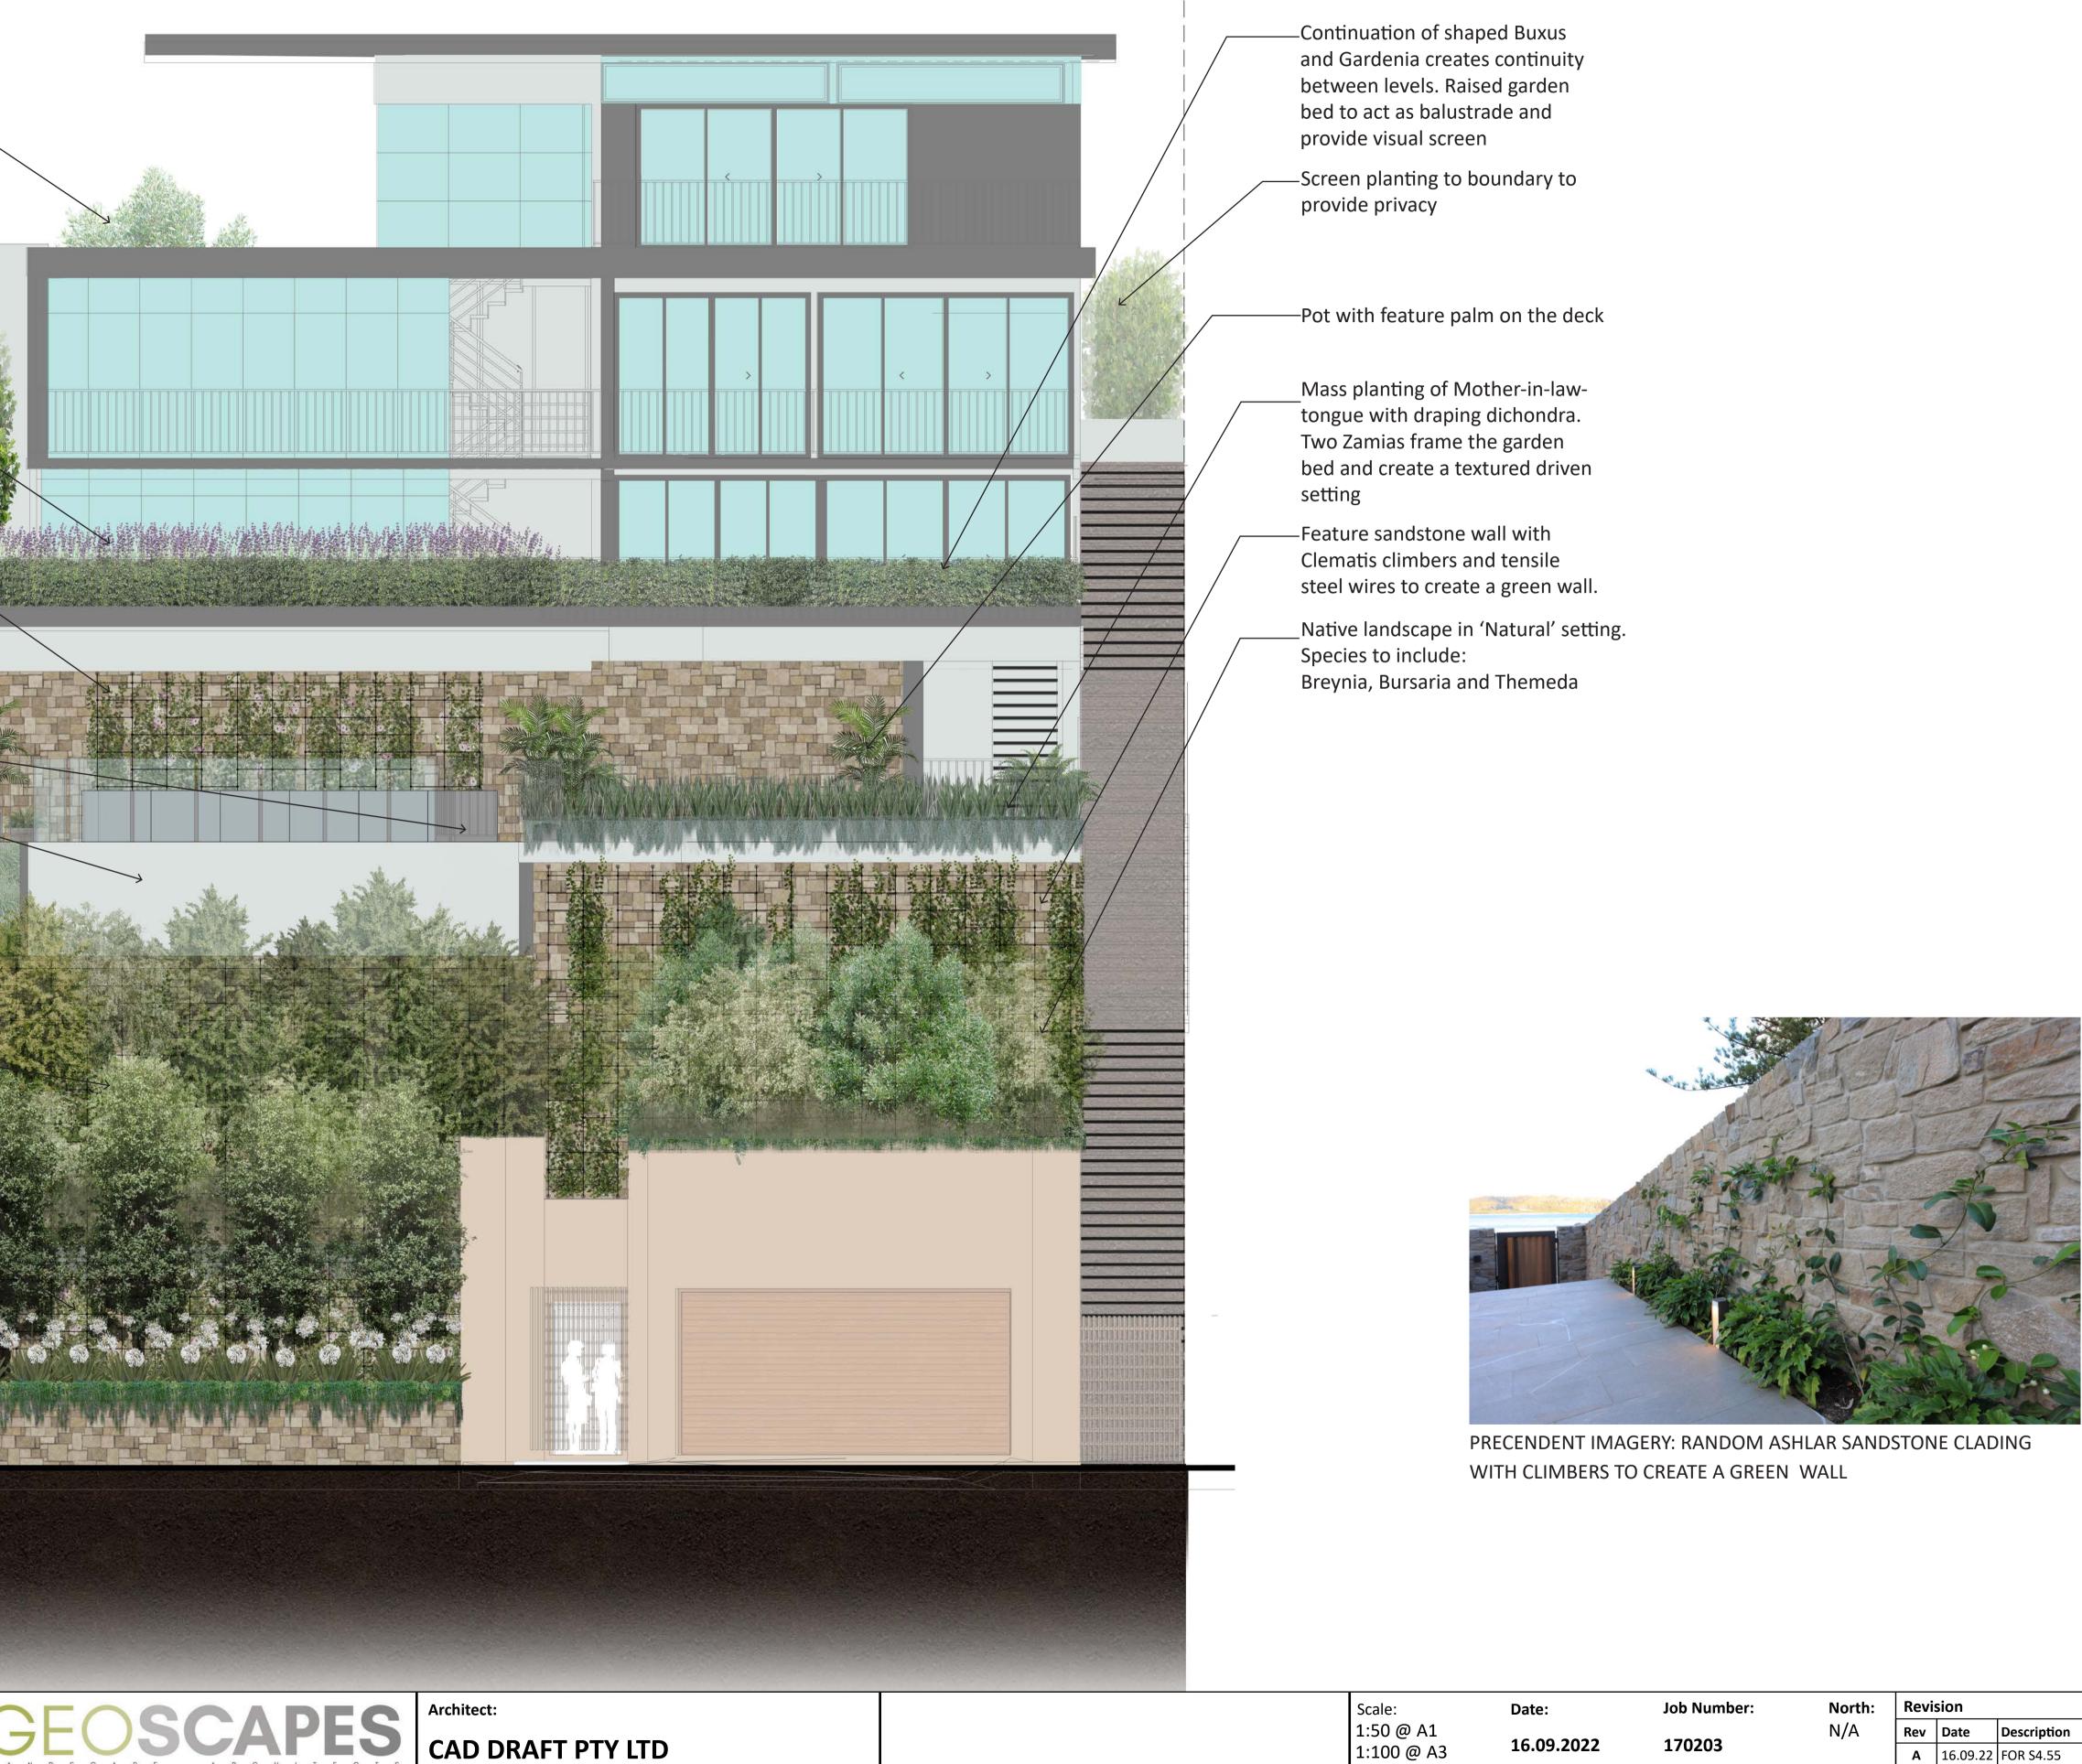

Project:

CAD DRAFT PTY LTD

Date:	Job Number:	North:	Revi	sion	F	FOR \$4.55		
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16.09.2022	170203		A	16.09.22	FOR \$4.55	PT	BG	
12 Riverview Road								
Earlwood, NSW 2206								

MAINTENANCE PLAN

Maintenance shall mean the care and maintenance of the landscape works by accepted horticultural practice as rectifying any defects that become apparent in the landscape works under normal use. The landscape contractor shall attend the site on a weekly basis for a 12 month period as per development consent condition no.5(e) to maintain the landscape works commencing from practical completion.

Rubbish Removal

The Landscape Contractor shall undertake rubbish removal from the site on a weekly basis to ensure the site remains in tidy condition.

Weed Eradication

Weed growth that may occur in grassed, planted or mulched areas is to be removed using environmentally acceptable methods i.e. non-residual glyphosate herbicide (e.g. 'Roundup', applied in accordance with the manufacturer's direction.

Tree Replacement

Trees shall show signs of healthy vigorous growth and be free from disease and not exhibit signs of stress prior to handover to the client. Any trees or plant that die or fail to thrive, or are damaged or stolen will be replaced. Replacement material shall have the initial maintenance period extended in accordance with the landscape contract conditions. Trees and plant materials shall be equal to the minimum requirements of species specified and approved material delivered to site. Should the condition decline from the approved sample the Superintendent reserves the right to reject the tree / plants. Frequency: as required.

Tree Supply

All the tree supply stocks shall comply with the guidance given in the publication Specifying Trees: a guide to assessment of tree quality by Ross Clark (NATSPEC, 2003).

Stakes

Adjust and/or replace stakes and ties where required. Remove staking and guying when instructed by the Superintendent

Pruning

Selective pruning may be required during the establishment period to promote a balanced canopy structure. These activities shall be carried out to the best horticultural and industry practice. All pruned material is to be removed from site.

Mulched Surfaces

All planter beds and garden areas shall have a minimum depth of 75mm pebble mulch or organic mulch. All mulch is to be free of deleterious matter such as soil, weeds, sticks and should conform to AS 4454.

Mulched surfaces are to be kept clean and tidy and free of any deleterious material and foreign matter. Reinstate depths to a uniform level of 75mm with mulch as specified, mulch to be free of any wood material impregnated with CCA or similar toxic treatment. Top up mulch levels prior to handover to client & estate management.

Watering

Implement an appropriate hand watering regime in areas not irrigated in association with current watering programme to maintain plant health and vigour. The program shall reflect seasonal conditions and plant species. Frequency: Weekly or as required.

Soil In Natural Ground

Non-Australian native garden beds to have soil installed consisting of 50% existing site topsoil and 50% new topsoil equal or equivalent to 'Organic Garden Mix' as supplied by Australian Native Landscapes. Australian native garden beds to have soil installed consisting of 50% existing site topsoil and 50% new topsoil equal or equivalent to 'Native Low 'P' Mix' as supplied by Australian Native Landscapes. Soil to conform to AS4419 refer to typical detail.

Pest and Disease Control

The Landscape Contractor shall spray for pests and disease infestations when the pest and fungal attack has been positively identified and when their populations have increased to a point that will become detrimental to plant growth. Apply all pesticides to manufacturer's directions.

Frequency: weekly inspection

Fertilising

Generally check for signs of nutrient deficiencies (yellowing of leaves, failure to thrive), and adapt fertiliser regime to suit. Fertiliser should be applied at the beginning and the end of the (summer) growing season.

Irrigation

A sub surface dripper style, electrically automated self timed irrigation system is to be supplied to all garden bed areas and planter container. Regular checks are to be made to ensure continued successful operation. The Landscape Contractor shall be responsible for coordination and engagement of a specialist irrigation designer and installation contractor to design, supply and install an automatic subterranean drip irrigation system to all raised planter beds.

The irrigation system will need to provide designated landscaped areas with enough water for vigorous healthy plant growth. As a general rule landscaped areas will need 20-25mm, species dependant, of water per week.

The landscape Contractor will need to monitor natural rainfall using a rain switch in order to set irrigation flow rates accordingly on a monthly basis.

Drawing Title

TYPICAL SPECIFICATION & DETAILS


S4.55-601



DWG No:


TYPICAL LANDSCAPE DETAILS

REE/SHRUB SIZE AND QUALITY TO BE TO NATSPEC STANDARD. SPECIES IS TO BE AS PER PLAN AND PLANT SCHEDULE. ENSURE ONLY HEALTHY AND VIGOROUS, DISEASE FREE, WELL MAINTAINED PLANTS ARE USED. FAKE CARE TO ENSURE FOLIAGE, BRANCHES, TRUNKS AND ROOT CROWNS ARE NOT DAMAGED BEFORE, DURING AND AFTER PLANTING

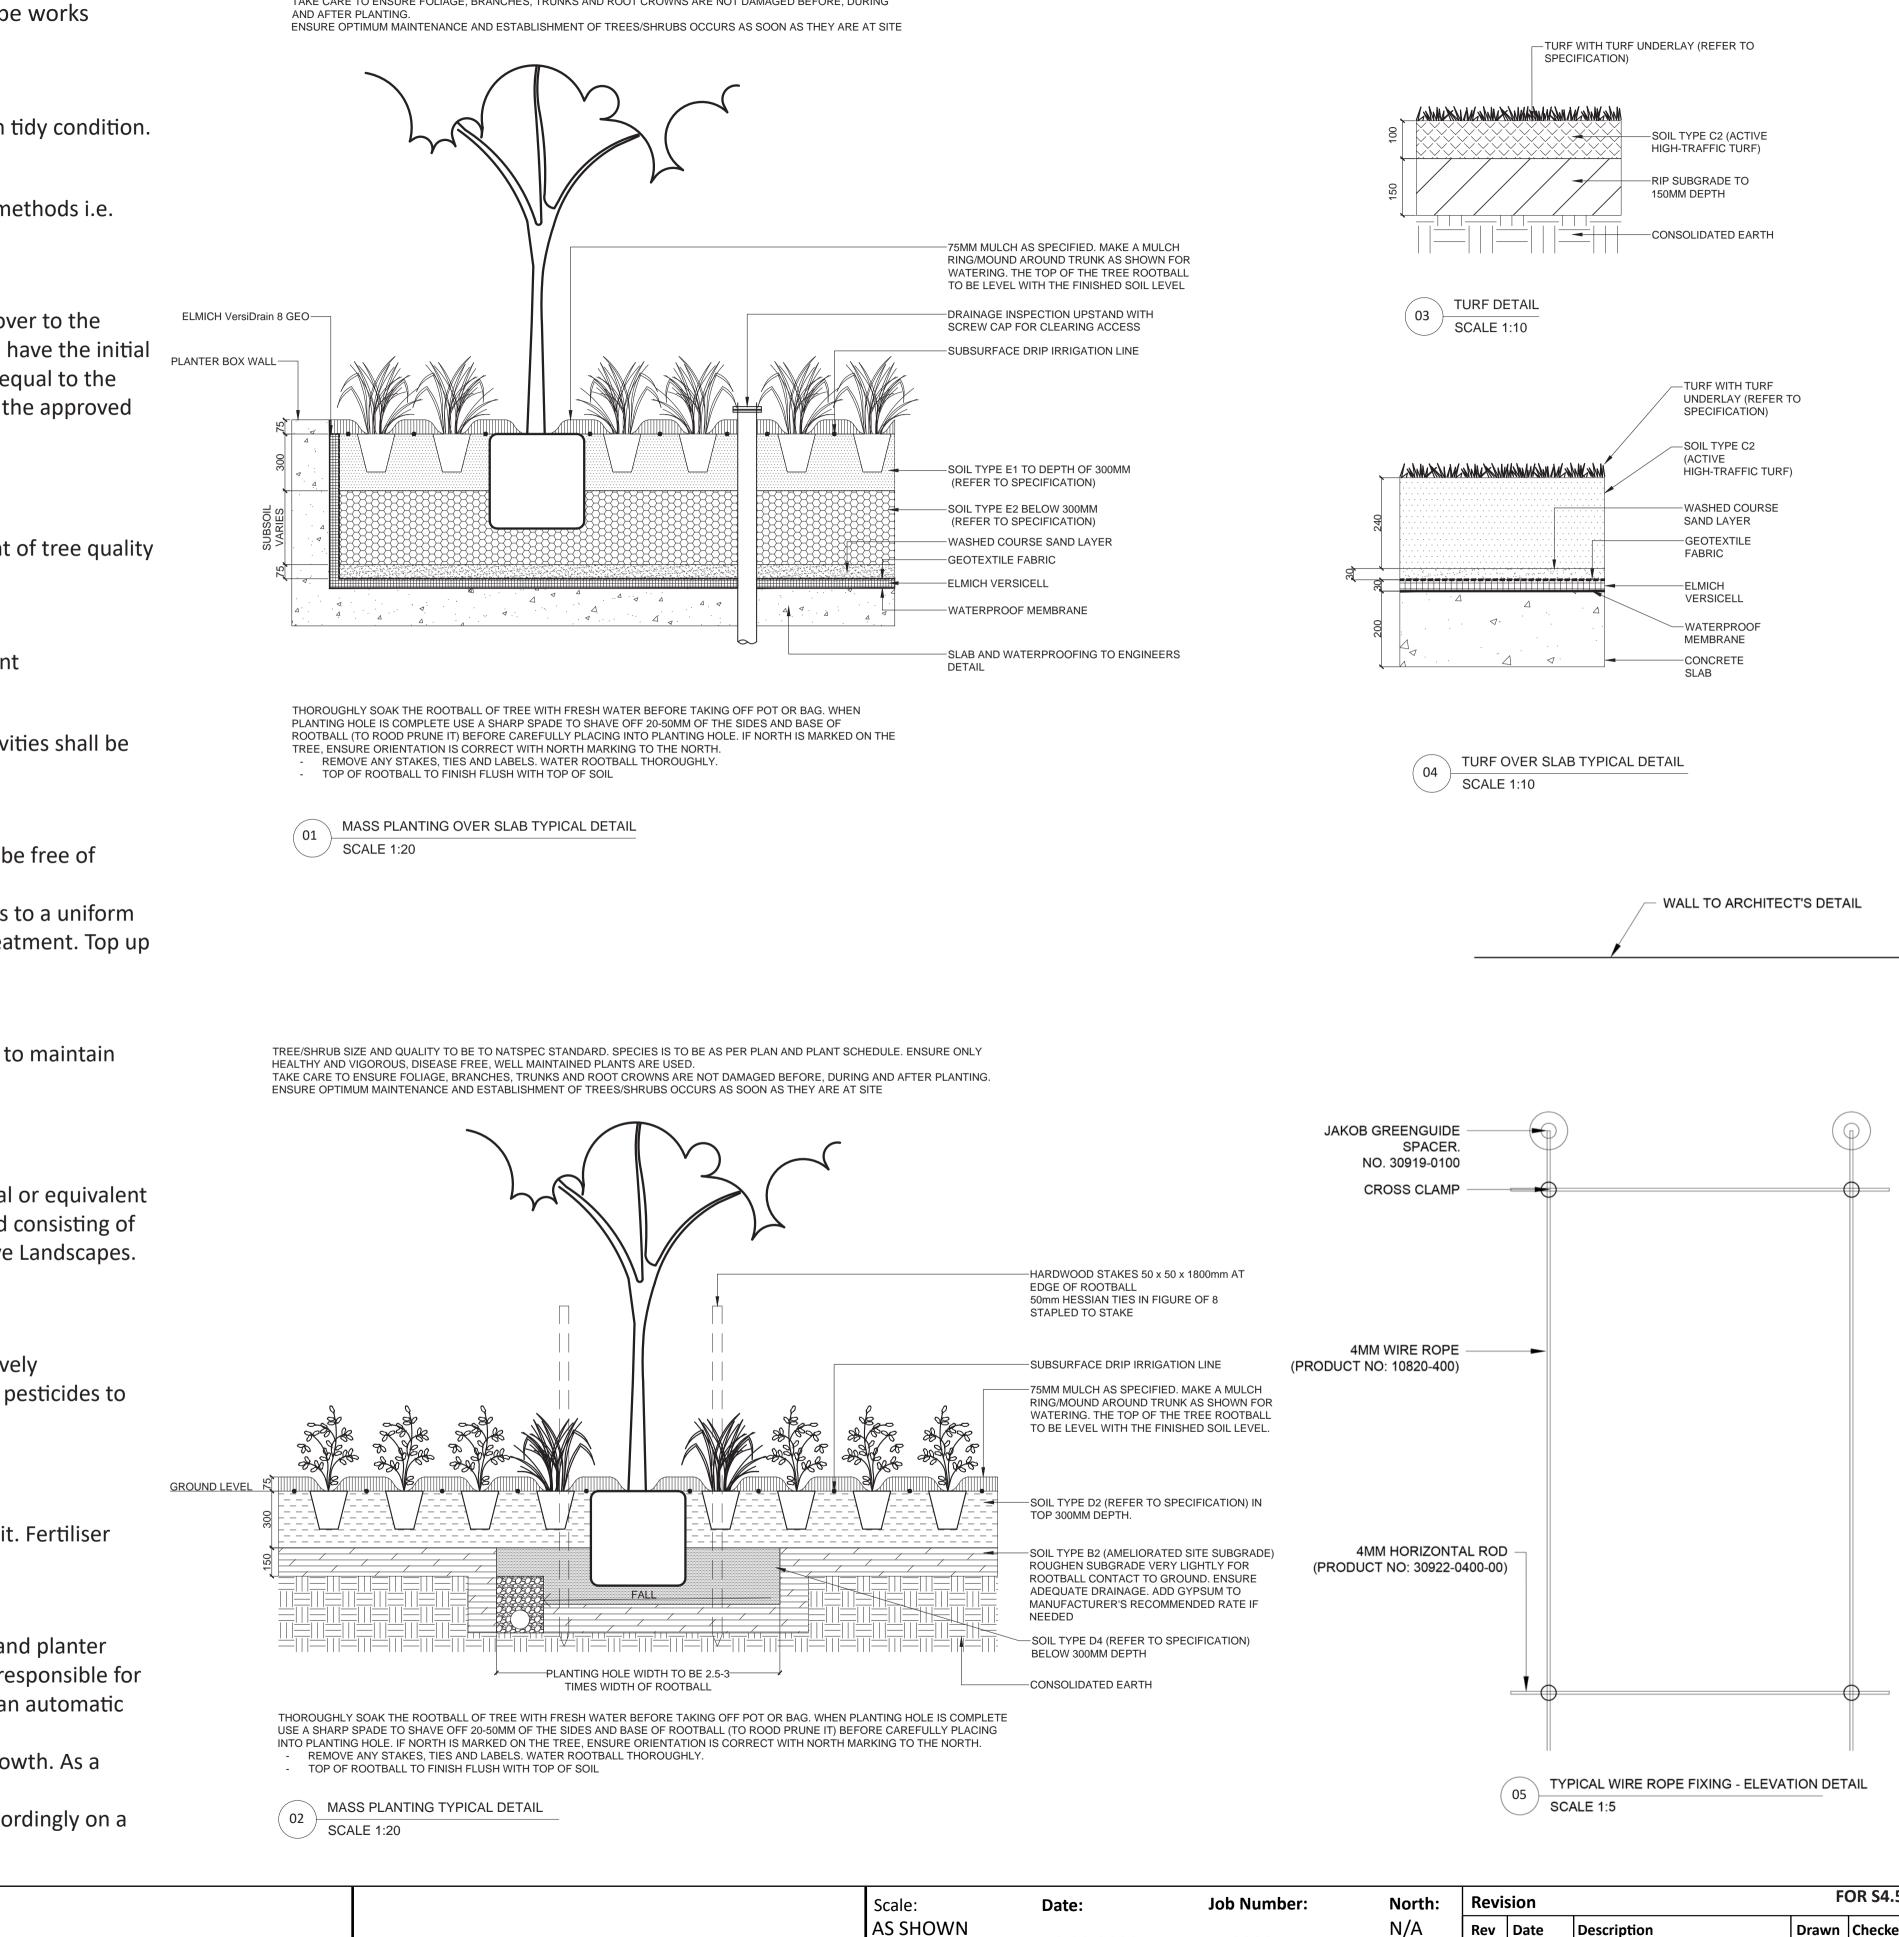

@ A1

Project:

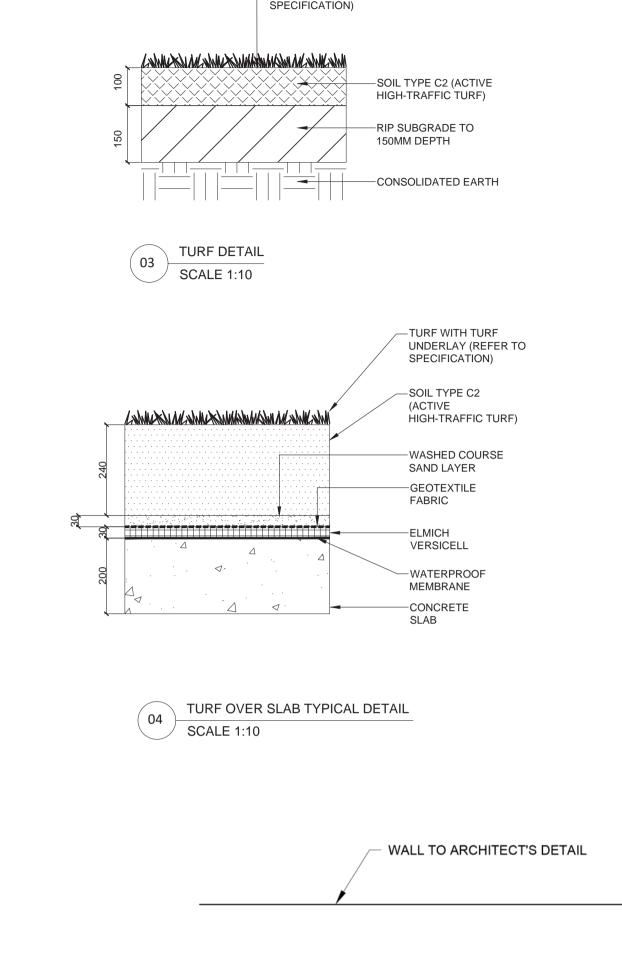

Date:	Job Number:	: North:		sion		FOR \$4.55		
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16.09.2022 170203		Α	16.09.22	FOR \$4.55	PT	BG		
12 Riverview Road Earlwood, NSW 2206								

PLANT SCHEDULE

Code	Botanical Name	Common Name	Expected Mature Height	Install Size	Spacing
	TREES				
BAC MYR	Backhousia myrtifolia	Grey Myrtle	7m	75L	As Shown
CER CHI	Cercis chinensis 'Avondale'	Avondale Cercis	3m	75L	As Shown
ELA EUM	Elaeocarpus eumundi	Eumundi Quandong	10m	75L	As Shown
ELA RET	Elaeocarpus reticulatus 'Prima Donna'	Blueberry Ash	9m	75L	As Shown
TRI LUS	tristaniopsis laurina 'luscious'	Water gum	6m	75L	As Shown
	PALMS				
HOW for	Howea forsteriana	Kentia palm	3m	75L	As Shown
	CYCADS				
ZAM FUR	Zamia furfuracea	Cardboard Palm	1.2m	75L	As Shown
	SHRUBS				
BRE obl	Breynia oblongifolia	Coffee Bush	3m	200mm	As Shown
BUR spi	Bursaria spinosa	Blackthorn	4.5m	75L	As Shown
BUX mic	Buxus microphylla var. Japonica	Japanese Box	1.5m	200mm	400mm Ctrs
KUN amb	Kunzea ambigua 'Rivan'	Tick Bush	2m	300mm	As Shown
PHI roj	Philodendron 'Rojo Congo'	Rojo Congo	2m	300mm	As Shown
PHI xan	Philodendron Xanadu	Xanadu	0.75m	200mm	As Shown
SAN sil	Sansevieria trifasciata 'Silver Queen'	Mother-In-Law-Tongue	0.75m	150mm	As Shown
ISO ane	Isopogon anemonifolius	Broad-leaved Drumsticks	1.2m	200mm	As Shown
VIB odo	Viburnum odoratissimum	Sweet Vibumum	2m	200mm	As Shown
WES blu	Westringia fruticosa 'Blue Gem'	Coastal Rosemary	1m	200mm	As Shown
	GRASSES AND GROUNDCOVERS				
AGA sno	Agapanthus hybrid 'Snowball'	Agapanthus Snowball	1.5m	140mm	As Shown
ALT den	Alternanthera dentata 'Little Ruby'	Alternanthera Little Ruby	0.4m	140mm	5/m2
DIA lon	Dianella longifolia	Pale Flax-lily	0.8m	140mm	5/m2
DIC rep	Dichondra repens	Kidney Weed	0.1m	140mm	11/m2
DIC sil	Dichondra 'Silver Falls'	Dichondra	0.3m	140mm	7/m2
GAR rad	Gardenia augusta 'Radicans'	Cape Jasmine	0.5m	140mm	4/m2
LAV ang	Lavandula angustifolia 'Hidcote'	English lavender	0.9m	140mm	4/m2
ROS off	Rosmarinus officinalis 'Prostratus'	Rosmarinus	0.3m	140mm	5/m2
THE aus	Themeda australis	Kangaroo Grass	1.5m	140mm	4/m2
	CLIMBERS				
CLE ari	Clematis aristata	Australian Clematis	Climbing	140mm	As Shown
PAN jas	Pandorea jasminoides	Bower Vine	Climbing	140mm	As Shown

Drawing Title **PLANT SCHEDULE & IMAGES** Architect:

ABN: 27 083 288 153 PH: 9555 8545 SUIT 4, 670 DARLING STREET, ROZELLE, NSW P.O BOX 446 GLADESVILLE 2111 in

DWG No:

PLANT IMAGES

ng	Quantity
wn	4
wn	1
wn	8
wn	4
wn	2
wn	4
wn	3
wn	3
wn	5
Ctrs	51
wn	3
wn	8
wn	4
wn	30
wn	9
wn	28
wn	3
wn	11
	35
	113
2	80
	80 56
	13
	16
	8
	82
wn	30
wn	30 29



Elaeocarpus reticulatus 'Prima Donna'



Howea forsteriana



Gardenia augusta 'Radicans'



Rosmarinus officinalis 'Prostratus'



Elaeocarpus eumundi



Zamia furfuracea



Clematis aristata



Dichondra repens





Bursaria spinosa





Scale: Date: Job Number: North N/A 16.09.2022 170203 N/A	Date:	Job Number:	North:	Revi	sion		F	FOR \$4.55	
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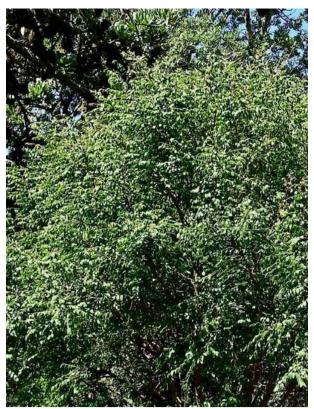


Kunzea ambigua 'Rivan'



Pandorea jasminoides

Agapanthus hybrid 'Snowball'



Breynia oblongifolia



Buxus microphylla var. Japonica



Philodendron Xanadu



Lavandula angustifolia 'Hidcote'